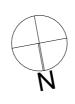


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١	project
	UNAUTHORISED CONVERSION
	APPROVED STUDIO TO GRANNY FLAT

Sheet Title:
SITE ANALYSIS

Client	Address
MASTER BUILDING GROUP PTY LTD	7 LAUMA AVENUE GREENACRE Lot 6 DP29227

Scale 1:200
Issue D Drawing No.:
7 Jauma

Date/Revision

Sheet Number:

14/02/25

Quality of Work: All work carried out must comply with: Building Code of Australia to the extent required under Environmental Planning Assessment Act 1979, all other relevant codes, standards and specifications that the work is required to comply with under any law and the conditions of any relevant development consent or complying development certificate and any construction certificate

GENERAL NOTES

VERIFY ON SITE BEFORE COMMENCEMENT OF ANY WORKS. IT IS THE CONTRACTORS RESPONSIBILITY TO CONFIRM ALL SITE CONDITIONS & REQUIREMENTS

FAILURE TO COMPLY WITH DRAWINGS & SPECIFICATIONS COULD RESULT IN ALTERATIONS BEING MADE AT THE COST TO THE CONTRACTOR.

THESE DRAWINGS MUST BE READ ON CONJUNCTION WITH ALL RELEVANT CONSULTANT'S DRAWINGS & SPECIFICATIONS INCLUDING, STRUCTURAL, MECHANICAL & HYDRAULIC. CONTRACTOR TO COMPLY WITH CURRENT HEALTH & SAFETY REGULATIONS AT ALL TIME. BEFORE COMMENCEMENT OF DEMOLITION WORKS THE CONTRACTOR MUST CONTACT THE CONSULTANT ENGINEER TO ESTABLISH WHICH WALLS, ETC ARE ABLE TO BE SAFELY REMOVED.

AUSTRALIAN STANDARDS COMPLIANCE

AS/NZS 1664 ALUMINUM STRUCTURES

THE BUILDING WORKS SHALL BE CONSTRUCTED IN ACCORDANCE WITH, BUT NOT LIMITED TO, THE FOLLOWING AUSTRALIAN STANDARDS:

A0/11/20 1004	ALOMINOMOTROCIONEO
AS/NZS 1905	COMPONENTS FOR THE PROTECTION OF OPENINGS IN FIRE RESISTANT WALLS
AS 2050	INSTALLATION OF ROOF TILES
AS 2047	WINDOWS IN BUILDINGS- SELECTION AND INSTALLATION
AS 2327	COMPOSITE STRUCTURES
AS 2870	RESIDENTIAL SLABS AND FOOTING CONSTRUCTION
AS 1684	RESIDENTIAL TIMBER - FRAMED CONSTRUCTION
AS 3700	MASONRY STRUCTURES
AS 3013	ELECTRICAL INSTALLATIONS
AS 1668	THE USE OF MECHANICAL VENTILATION AND
	- AIR CONDITIONING IN BUILDINGS
AS 2441	INSTALLATION OF HOSE REELS
AS 3786	SMOKE ALARMS
AS 1288	GLASS IN BUILDINGS - SELECTION AND INSTALLATION
AS 2107	ACOUSTICS - RECOMMENDED DESIGN SOUND LEVELS AN
	REVERBERATION
	TIMES FOR BUILDING INTERIORS
AS 3660.	TERMITE MANAGEMENT - NEW BUILDING WORK
2000	
AS/NZS 2890.	1 OFF-STREET PARKING
2004	

AS 374(- 2010 WATERPROOFING OF DOMESTIC WET AREAS

BUILDING CODE OF AUSTRALIA BUILDING CLASSIFICATION: 1

BCA COMPLIANCE

Section A General Provisions

Vol. 2 Part 1.3, Clause 1.3.2 Classifications:

CLASS 1: One or more buildings which in association constitute -

(a) Class 1A - A single dwelling, being -

a detached house, or

one or more attached dwellings, each being a building,

separated by a fire-resisting wall, including a row house, terrace house, town house or villa unit;

CLASS 10: A non-habitable building being a private garage, carport, shed, or the like.

Section C Fire Separation Part 3.7.1 Fire Separation

Application

Compliance with this Part satisfies Performance Requirement P2.3.1 for fire separation.

General Concession - Non-combustible materials 3.7.1.2 The following materials, though combustible or containing combustible fibers, may be used wherever a noncombustible is required in the Housing Provisions:

(a) plasterboard, and

(b) perforated gypsum lath with a normal paper finish, and

(c) fibrous-plaster sheet, and

(d) fiber-reinforced cement sheeting, and

(e) pre-finished metal sheeting having a combustible surface finish not exceeding 1mm thick and

where the Spread-of-Flame Index of the product is not more than 0: and

(f) bonded laminated materials, where -

(i) each laminate is non-combustible; and

(ii) each adhesive layer is not more than 1mm thick; and

the total thickness of adhesive lavers is not more than

2mm; and

(iii)

the Spread-of-Flame Index and the Smoke-Development

Index of the laminated material as a whole does not exceed 0 and 3 respectively

3.7.1.3 External Walls of Class 1 buildings

An external wall of a Class 1 building and any openings in that wall must comply with 3.7.1.5, if the wall is less than-

900mm from the allotment boundary other than the boundary adjoining a road alignment or other public space; or

1.8m from another building on the same allotment other than appurtenant Class 10 building or a detached part of the same Class 1 building.

Measurement of distances

The distance from any point on an external wall of a building to an allotment boundary or another

building is the distance to that point measured along a line at right angles from the allotment

boundary or external wall of the other building which intersects that point without obstruction by a

wall complying with 3.7.1.5.

Where a wall within a specified distance is required to be constructed in a certain manner, only

that part of the wall, (including any openings) within the specified distance, must be constructed in

that manner.

3.7.1.5 Construction of External Walls (a)

External walls (including gables) required to be fireresisting

[Referred to in3.7.1.3 or 3.7.1.6] must

extend to the underside of a non-combustible roof covering or non-combustible eaves lining, and musthave an FRL of not less than 60/60/60 when tested from

the outside; or

be of masonry-veneer construction in which the external masonry veneer is not less

than 90mm thick; or

be of masonry construction not less than 90mm thick. (iii) Openings in external walls required to be fire-resisting

[referred to in 3.7.1.3 or

[3.7.1.6] must be protected by-

non-operable fire-windows or other construction with an FRL of not less than --/60/--: or

self-closing solid-core doors not less than 35mm thick. (ii)

Sub-floor vents, roof vents, weep holes and penetrations for pipes, conduits and the like need not comply with (b) above.

Concessions for non-habitable room windows, conduits and the like-Despite the requirements in (b), in a non-habitable room a window that faces the boundary of an

adjoining allotment may be not less than 600mm from that boundary, or, where the building faces

another building on the same allotment, not less than 1.2m from that building; providing that-

in a bathroom, laundry or toilet, the opening has an area of not more

than 1.2sqm; or (ii) in a room other than referred to in (i), opening has an area of not

more than 0.54sqm: and-

(A) the window is steel-framed, there are no opening sashes and it is glazed in

wire glass; or

the opening is enclosed with hollow glass blocks.

3.7.1.8 Separating walls

(a) A wall that separates Class 1 dwellings, or separates a Class 1 building from a Class 10a building

which is not appurtenant to that Class 1 building, must have an FRL of not less than 60/60/60, and-

(i) commence at the footings or ground slab; and

(ii) extend-

(A) if the building has a non-combustible roof covering, to the underside of the roof covering; or

(B) if the building has a combustible roof covering, to not less than 450mm above the roof covering.

SPECIFICATIONS C1.10 Fire Hazard Properties

Materials used in the building having flammability, smoke developed and spread-of-flame indices as set-out in spec C1.10.

SECTION F Health and Amenity

Part F1: Damp and Weatherproofing

Stormwater drainage must comply with AS/NZS 3500.3.2

Roof covering to comply with F1.5

Sarking must comply with AS/NZS 4200, Parts 1 and 2

Water proofing of wet areas in buildings to comply with F1.7

Damp-proofing of floors on ground to comply with F1.11 Part F3.7: Fire safety

-Automatic fire detection system to be provided in accordance with Part 3.7.2 General concession:

Part 3.7.2: Smoke alarms - requirements for smoke alarms:

(a) Smoke alarms must be installed in:

(i) any storey containing bedrooms.

Part 3.8: Health and amenity

- Wet areas within the building must comply with the requirements of Part 3.8.1 Wet areas.

Part 3.8.6: Sound insulation requirements

3.8.6.1: Application - Compliance with this Part satisfies performance requirement P2.4.6 for sound insulation.

3.8.6.2: Sound insulation requirements

(a) to provide insulation from air-born and impact sound, a separating wall between two or more Class

1 buildings, must-

Client

achieve the weighted sound reduction with spectrum adaption term Rw+Ctrl and

discontinuous construction

requirements, as required by Table 3.8.6.1; and

be installed in accordance with the appropriate requirements of 3.8.6.3 and 3.8.6.4

For the purpose of this Part, the Rw+Ctr must be determined in accordance with As/NZS 1276.2 or

ISO 717.1, using results from laboratory measurements.

MASTER BUILDING GROUP PTY LTD

Part 3.9: Safe movement and access

The treads and risers of the proposed stairs are to comply with Part 3.9.1.2 General requirements.

Address

DP29227

7 LAUMA AVENUE

GREENACRE Lot 6

GENERAL NOTES

ALL WORK TO BE CARRIED OUT IN ACCORDANCE WITH THE REQUIREMENTS OF THE PRINCIPAL CERTIFYING AUTHORITY [PCA] AND THE BUILDING CODE OF AUSTRALIA (BCA) - AS AMENDED.

REMOVAL OF ASBESTOS CEMENT SHEETING MUST BE CARRIED OUT BY A LICENSED CONTRACTOR IN COMPLIANCE WITH THE REQUIREMENTS OF THE NSW WORKCOVER AUTHORITY IN RELATION TO THE REMOVAL, HANDLING AND DISPOSAL OF ALL MATERIAL CONTAINING ASBESTOS: AND THE WORK SAFE AUSTRALIA ASBESTOS CODE OF PRACTICE AND GUIDANCE NOTES.

ALL DEMOTION WORK TO BE CARRIED OUT IN ACCORDANCE WITH AS2601 AS CURRENTLY AMENDED

BUILDER SHALL MAKE GOOD ALL DISTURBED AREAS ADJACENT TO THE WORKS ON COUNCILS ROODS. FOOTPATHS ARE TO BE RESTORED TO THE SATISFACTION OF THE PCA. ALL CONCRETE FOOTINGS. FLOOR SLABS. COLUMNS AND TIMBER ROOF FRAMING TO STRUCTURAL ENGINEER'S

ALL STORMWATER REQUIREMENTS, EXTERNAL AND DRIVEWAY LEVELS TO HYDRAULIC ENGINEER'S DERAILS.

ALL LANDSCAPED AREAS. EXISTING TREES. DRIVEWAY, DRYING YARDS AND FENCING TO LANDSCAPE ARCHITECT'S DETAILS.

DRAWINGS ARE TO BE READ IN CONJUNCTION WITH SPECIFICATIONS.

ALL STAIR TREADS ARE TO BE EQUAL TO 250MM DEEP.

ALL MATERIALS AND COMPONENTS SHALL COMPLY WITH THE EARLY HAZARD INDICES REQUIREMENTS OF BCA SPEC. CLAUSE 1.10.

ALL ASPECTS OF THE BUILDING WORK SHALL COMPLY WITH THE RELEVANT CURRENT PROVISIONS OF THE LOCAL GOVERNMENT REGULATIONS AND THE BUILDING CODE OF AUSTRALIA.

SILT/SEDIMENT CONTROL MEASURES ARE TO BE IN PLACE PRIOR TO ANY EXCAVATION OR CONSTRUCTION WORK. SAFETY GLASS SHALL BE USED IN EVERY GLASS DOOR OR PANEL

ENCLOSING OR PATTY ENCLOSING A SHOWER OR BATH. PROTECTIVE MEASURES ARE REQUIRED FOR EACH TREE BEING RETAINED

ON SITE AND SHALL BE ESTABLISHED BEFORE BUILDING WORKS COMMENCE, AND SHALL BE CONSTRUCTED AND MAINTAINED AS PER COUNCIL REQUIREMENTS. THE REFLECTIVITY INDEX OF ALL EXTERNAL GLASS MATERIALS IS NOT TO

EXCEED 20%. PEDESTRIAN TRAFFIC AND USE OF BOUNDING PUBIC FOOTPATHS, SPACE TO REMAIN UN-CONSTRICTED (UNLESS SUBJECT TO SEPARATE COUNCIL APPROVAL], INCLUDING PRAM ACCESS TO BE MAINTAINED IN ACCORDANCE WITH AS1742.3

'PART 3' - TRAFFIC CONTROL DEVICES FOR WORKS ON ROADS' ALL BATHROOMS AND WC WINDOWS TO BE INSTALLED WITH OBSCURE GLASS, UNLESS THE DOOR IS A SANITARY COMPORTMENT THAT SWINGS OUTWARD OR IS GREATER THAN I.2M AWAY FROM THE TOILET SUITE, THE DOOR MUST BE INSTALLED WITH REMOVABLE 'LIFT-OFF HINGES.

SEDIMENT CONTROL NOTES

RELEVANT WORKS ARE COMPLETED

- . ALL EROSION AND SEDIMENT CONTROL MEASURES, INCLUDING RE VEGETATION AND STORAGE OF SOIL AND TOPSAIL SHALL BE IMPLEMENTED TO THE STANDARDS OF SOIL CONSERVATION OF NSW
- 2. AL DRAINAGE WORKS SHALL BE CONSTRUCTED AND STABILIZED AS EARLY AS POSSIBLE DURING DEVELOPMENT
- 3. SEDIMENT TRAPS SHALL BE CONSTRUCTED AROUND ALL INLET PITS, CONSISTING OF 450MM WIDE BY 450RNM DEEP TRENCH. 4. ALL SEDIMENT BASINS AND TRAPS SHALL BE CLEANED WHEN
- STRUCTURES ARE A MAXIMUM OF 60% FULL OF SOIL MATERIALS, INCLUDING THE MAINTENANCE PERIOD 5. ALL DISTURBED AREAS SHALL BE RE-VEGETATED AS SOON AS THE
- 6. SOIL AND TOPSOIL STOCKPILES SHALL BE LOCATED AWAY FROM DRAINAGE LINES AND AREA WHERE WATER MAY CONGREGATE.
- 7. FILTER SHALL BE CONSTRUCTED BY STRETCHING A FILTER FABRIC (PROPEX OR APPROVED EQUIVALENT] BETWEEN POSTS AT 3.0M CENTRES. FABRIC SHALL BE BURIED 150MM ALONG ITS LOWER EDGE.
- 8 REFER TO CONCEPT STORMWATER ENGINEERING FOR CLARITY AND STRUCTURE DETAIL

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BUILDING CODES COMPLIANCE

Date/Revision Scale 14/02/25 Drawing No Sheet Number:

7lauma

Quality of Work: All work carried out must comply with: Building Code of Australia to the extent required under Environmental Planning Assessment Act 1979, all other relevant codes, standards and specifications that the work is required to comply with under any law and the conditions of any relevant development consent or complying development certificate and any construction certificate.

THESE NOTES MUST BE READ AND UNDERSTOOD BY ALL INVOLVED IN THE PROJECT. THIS INCLUDES (but is not excluded to): OWNER, BUILDER, SUB-CONTRACTORS, CONSULTANTS, RENOVATORS, OPERATORS, MAINTENORS, DEMOLISHERS.

1. FALLS, SLIPS, TRIPS

a) WORKING AT HEIGHTS

DURING CONSTRUCTION

Wherever possible, components for this building should be prefabricated off-site or at ground level to minimise the risk of workers falling more than two metres. However, construction of this building will require workers to be working at heights where a fall in excess of two metres is possible and injury is likely to result from such a fall. The builder should provide a suitable barrier wherever a person is required to work in a situation where falling more than two metres is a possibility.

DURING OPERATION OR MAINTENANCE

For houses or other low-rise buildings where scaffolding is appropriate:

Cleaning and maintenance of windows, walls, roof or other components of this building will require persons to be situated where a fall from a height in excess of two metres is possible. Where this type of activity is required, scaffolding, ladders or trestles should be used in accordance with relevant codes of practice, regulations or legislation.

For buildings where scaffold, ladders, trestles are not appropriate: Cleaning and maintenance of windows, walls, roof or other components of this building will require persons to be situated where a fall from a height in excess of two metres is possible. Where this type of activity is required, scaffolding, fall barriers or Personal Protective Equipment (PPE) should be used in accordance with relevant codes of practice, regulations or legislation.

b) SLIPPERY OR UNEVEN SURFACES

FLOOR FINISHES Specified

If finishes have been specified by designer, these have been selected to minimise the risk of floors and paved areas becoming slippery when wet or when walked on with wet shoes/feet. Any changes to the specified finish should be made in consultation with the designer or, if this is not practical, surfaces with an equivalent or hetter slip resistance should be chosen FLOOR FINISHES By Owner

If designer has not not been involved in the selection of surface finishes, the owner is responsible for the selection of surface finishes in the pedestrian trafficable areas of this building. Surfaces should be selected in accordance with AS HB 197:1999 and AS/NZ

STEPS, LOOSE OBJECTS AND UNEVEN SURFACES.

Due to design restrictions for this building, steps and/or ramps are included in the building which may be a hazard to workers carrying objects or otherwise occupied. Steps should be clearly marked with both visual and tactile warning during construction, maintenance, demolition and at all times when the building operates as a workplace

Building owners and occupiers should monitor the pedestrian access ways and in particular access to areas where maintenance is routinely carried out to ensure that surfaces have not moved or cracked so that they become uneven and present a trip hazard. Spills, loose material, stray objects or any other matter that may cause a slip or trip hazard should be cleaned or removed from access ways.

Contractors should be required to maintain a tidy work site during construction, maintenance or demolition to reduce the risk of trips and falls in the workplace. Materials for construction or maintenance should be stored in designated areas away from access ways and work areas.

2. FALLING OBJECTS

LOOSE MATERIALS OR SMALL OBJECTS

Construction, maintenance or demolition work on or around this building is likely to involve persons working above ground level or above floor levels. Where this occurs one or more of the following measures should be taken to avoid objects falling from the area where the work is being carried out onto persons below.

- 1. Prevent or restrict access to areas below where the work is being carried out.
- Provide toeboards to scaffolding or work platforms.
- Provide protective structure below the work area.
- Ensure that all persons below the work area have Personal Protective Equipment (PPE).

BUILDING COMPONENTS

During construction, renovation or demolition of this building, parts of the structure including fabricated steelwork, heavy panels and many other components will remain standing prior to or after supporting parts are in place. Contractors should ensure that temporary bracing or other required support is in place at all times when collapse which may injure persons in the area is a possibility.

Mechanical lifting of materials and components during construction, maintenance or demolition presents a risk of falling objects. Contractors should ensure that appropriate lifting devices are used that loads are properly secured and that access to areas below the load is prevented or restricted.

3. TRAFFIC MANAGEMENT

For building on a major road, narrow road or steeply sloping road: Parking of vehicles or loading/unloading of vehicles on this roadway may cause a traffic hazard. During construction, maintenance or demolition of this building designated parking for workers and loading areas should be provided. Trained traffic management personnel should be responsible for the supervision of these areas. For building where on-site loading/unloading is restricted: Construction of this building will require loading and unloading of materials on the roadway. Deliveries should be well planned to avoid congestion of loading areas and trained traffic management personnel should be used to supervise loading/unloading areas.

Busy construction and demolition sites present a risk of collision where deliveries and other traffic are moving within the site. A traffic management plan supervised by trained traffic management personnel should be adopted for the work site.

4. SERVICES

Rupture of services during excavation or other activity creates a variety of risks including release of hazardous material. Existing services are located on or around this site. Where known, these are identified on the plans but the exact location and extent of services may vary from that indicated. Services should be located using an appropriate service (such as Dial Before You Dig), appropriate excavation practice should be used and, where necessary, specialist contractors should be used. Locations with underground power:

Underground power lines MAY be located in or around this site. All underground power lines must be disconnected or carefully located and adequate warning signs used prior to any construction, maintenance or demolition commencing Locations with overhead power lines:

Overhead power lines MAY be near or on this site. These pose a risk of electrocution if struck or approached by lifting devices or other plant and persons working above ground level. Where there is a danger of this occurring, power lines should be, where practical, disconnected or relocated. Where this is not practical adequate warning in the form of bright coloured tape or signage should be used or a protective barrier provided.

5. MANUAL TASKS

Components within this design with a mass in excess of 25kg should be lifted by two or more workers or by mechanical lifting device. Where this is not practical, suppliers or fabricators should be required to limit the component mass. All material packaging, building and maintenance components should clearly show the total mass of packages and where practical all items should be stored on site in a way which minimises bending before lifting. Advice should be provided on safe lifting methods in all areas where lifting may occur. Construction, maintenance and demolition of this building will require the use of portable tools and equipment. These should be fully maintained in accordance with manufacturer's specifications and not used where faulty or (in the case of electrical equipment) not carrying a current electrical safety tag. All safety guards or devices should be regularly checked and Personal Protective Equipment should be used in accordance with manufacturer's specification.

6. HAZARDOUS SUBSTANCES **ASBESTOS**

For alterations to a building constructed prior to 1990: If this existing building was constructed prior to: 1990 - it therefore may contain asbestos 1986 - it therefore is likely to contain asbestos either in cladding material or in fire retardant insulation material. In either case, the builder should check and, if necessary, take appropriate action before demolishing, cutting, sanding, drilling or otherwise disturbing the existing structure.

POWDERED MATERIALS

Many materials used in the construction of this building can cause harm if inhaled in powdered form. Persons working on or in the building during construction, operational maintenance or demolition should ensure good ventilation and wear Personal Protective Equipment including protection against inhalation while using powdered material or when sanding, drilling, cutting or otherwise disturbing or creating powdered material.

TREATED TIMBER

The design of this building may include provision for the inclusion of treated timber within the structure. Dust or fumes from this material can be harmful. Persons working on or in the building during construction, operational maintenance or demolition should ensure good ventilation and wear Personal Protective Equipment including protection against inhalation of harmful material when sanding. drilling, cutting or using treated timber in any way that may cause harmful material to be released. Do not burn treated timber.

VOLATILE ORGANIC COMPOUNDS

Many types of glue, solvents, spray packs, paints, varnishes and some cleaning materials and disinfectants have dangerous emissions. Areas where these are used should be kept well ventilated while the material is being used and for a period after installation. Personal Protective Equipment may also be required. The manufacturer's recommendations for use must be carefully considered at all times.

SYNTHETIC MINERAL FIBRE

Fibreglass, rockwool, ceramic and other material used for thermal or sound insulation may contain synthetic mineral fibre which may be harmful if inhaled or if it comes in contact with the skin, eyes or other sensitive parts or the body. Personal Protective Equipment including protection against inhalation of harmful material should be used when installing, removing or working near bulk insulation material.

This building may contain timber floors which have an applied finish Areas where finishes are applied should be kept well ventilated during sanding and application and for a period after installation. Personal Protective Equipment may also be required. The manufacturer's recommendations for use must be carefully considered at all times.

7. CONFINED SPACES

EXCAVATION

Construction of this building and some maintenance on the building will require excavation and installation of items within excavations. Where practical, installation should be carried out using methods which do not require workers to enter the excavation. Where this is not practical, adequate support for the excavated area should be provided to prevent collapse. Warning signs and barriers to prevent accidental or unauthorised access to all excavations should be provided.

ENCLOSED SPACES

For buildings with enclosed spaces where maintenance or other access may be required:

Enclosed spaces within this building may present a risk to persons entering for construction, maintenance or any other purpose. The design documentation calls for warning signs and barriers to unauthorised access. These should be maintained throughout the life of the building. Where workers are required to enter enclosed spaces, air testing equipment and Personal Protective Equipment should be provided.

SMALL SPACES

For buildings with small spaces where maintenance or other access may be required:

Some small spaces within this building will require access by construction or maintenance workers. The design documentation calls for warning signs and barriers to unauthorised access. These should be maintained throughout the life of the building. Where workers are required to enter small spaces they should be scheduled so that access is for short periods. Manual lifting and other manual activity should be restricted in small spaces.

8. PUBLIC ACCESS

Public access to construction and demolition sites and to areas under maintenance causes risk to workers and public. Warning signs and secure barriers to unauthorised access should be provided. Where electrical installations, excavations, plant or loose materials are present they should be secured when not fully supervised.

9. OPERATIONAL USE OF BUILDING RESIDENTIAL BUILDINGS

This building has been designed as a residential building. If it, at a later date, it is used or intended to be used as a workplace, the provisions of the Work Health and Safety Act 2011 or subsequent replacement Act should be applied to the new use.

10.OTHER HIGH RISK ACTIVITY

All electrical work should be carried out in accordance with Code of Practice: Managing Electrical Risks at the Workplace, AS/NZ 3012 and all licensing requirements.

All work using Plant should be carried out in accordance with Code of Practice: Managing Risks of Plant at the Workplace. All work should be carried out in accordance with Code of Practice: Managing Noise and Preventing Hearing Loss at Work. Due to the history of serious incidents it is recommended that particular care be exercised when undertaking work involving steel construction and concrete placement. All the above applies

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Client

UNAUTHORISED CONVERSION APPROVED STUDIO TO GRANNY FLAT

MASTER BUILDING GROUP PTY LTD

Sheet Title:

Scale

SAFETY NOTES

7 LAUMA AVENUE **GREENACRE Lot 6**

DP29227

Drawing No

7lauma

14/02/25 Sheet Number:

Quality of Work: All work carried out must comply with: Building Code of Australia to the extent required under Environmental Planning Assessment Act 1979, all other relevant codes, standards and specifications that the work is required to comply with under any law and the conditions of any relevant development consent or complying development certificate and any construction certificate.

ENVIRONMENTAL SITE MANAGEMENT NOTES

- All existing trees to be retained unless shown otherwise on approved Architect's or Landscape drawings. Trees retained are to be protected with a high visibility fence, plus flagging to individual trees as necessary.
- Retain all existing grass cover wherever possible.
- Sediment and erosion controls must be in place prior to the commencement of any earthworks of demolition activity.
- Install temporary sediment barriers to all inlet pits likely to collect silt laden water, until surrounding areas are paved or regrassed.
- All silt fences and barriers are to be maintained in good order and regularly desilted during the construction period.
- It is the responsibility of the contractor to ensure that all measures are taken during the course of construction to prevent sediment erosion and pollution of the downstream system. Supervising engineer should be contacted if in doubt. It is the responsibility of the contractor to ensure that all measures are taken
- during the course of construction to prevent sediment erosion and pollution of the downstream system. Supervising engineer should be contacted if in doubt. Waste materials are to be stockpiled or loaded into Utility vehicles located as
- stockpiles of loose material such as sand, soil, gravel must be covered with geotextile silt fence material. Plastic sheeting or membrane must not be used. Safety barricading should be used to isolate stockpiles of solid materials such as steel reinforcing, formwork, scaffolding.
- All vehicles leaving the site must pass over the 'ballast' area to shake off site clay and soil. If necessary wheels and axles are to be hose down. Ballast is to be maintained and replaced as necessary during the construction period.
- Delivery and other motor vehicles removing excavated material should travel on stabilised construction paths and material should be taken to the truck to reduce truck movement on the site.
- Any sediment deposit on the public way, including footpath reserve and road surface, is to be removed immediately.
- Provide barriers round all construction works within the footpath area to provide safe access for pedestrians.
- Concrete pumps and cranes are to operate from within the ballast entry driveway area and are not to operate from the public roadway unless specific council permission is obtained.
- delivery vehicles must not stand within the public roadway for more than 20 minutes at a time.
- Any excavation work adjacent to adjoining properties or the public roadway is not to be commenced until the structural engineer is consulted and specific instructions received from the engineer.
- Toilet facilities must be either a flushing type or approved portable chemical closet. Chemical closets are to be maintained and serviced on a regular basis so that offensive odour is not emitted.

Soil Note

Slab Level to form Datum to be Determined on Site & to Existing FFL Retaining walls to be completed to engineers details (if required) Sewer connection to Existing Connection Dish drains (if Needed) to Authorities Details Smoke Alarms to be Mains Connected There are no existing trees to be removed.

Soil Management

All excess soil on site generated as a result of necessary excavations to be re-used as fill to sub base of raft slab and to achieve a levelled building platform.

SEDIMENTATION CONTROL NOTES

ALL EROSION AND SEDIMENTATION CONTROL MEASURE, INCLUDING REVEGETATION AND STORAGE OF SOIL AND TOPSOIL. SHALL BE IMPLEMENTED TO THE STANDARDS OF THE SOIL CONSERVATION OF

- 2. DRAINAGE WORKS SHALL BE CONSTRUCTED AROUND ALL INLET PITS, CONSISTING OF 300MM W X 300MM D TRENCH.
- 3. ALL SEDIMENT BASINS AND TRAPS SHALL BE CLEANED WHEN AT A MAXIMUM OF 60% FULL OF SOIL MATERIALS.
- 4. ALL DISTURBED AREAS SHALL BE REVEGETATED AS SOON AS THE RELEVANT WORKS ARE COMPLETED.
- 5. SOIL AND TOPSOIL STOCKPILES SHALL BE LOCATED AWAY FROM DRAINAGE LINES AND AREAS WHERE WATER MAY CONCENTRATE.
- 6. FILTER SHALL BE CONSTRUCTED BY STRETCHING A FILTER FABRIC (PROPEX OR EQUIVALENT) BETWEEN POSTS AT 2M CENTRES. FABRIC SHALL BE BURIED 200MM ALONG THE BOTTOM EDGE

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Existing Dwelling Alfresco..

Existing Dwelling Balcony...

TOTAL

Site Area

FSR...

POS.


SITE COVERAGE:

Landscape Area..

Soft Soil Area..

Site Cover....

Existing Garage Store Room......10.00m²

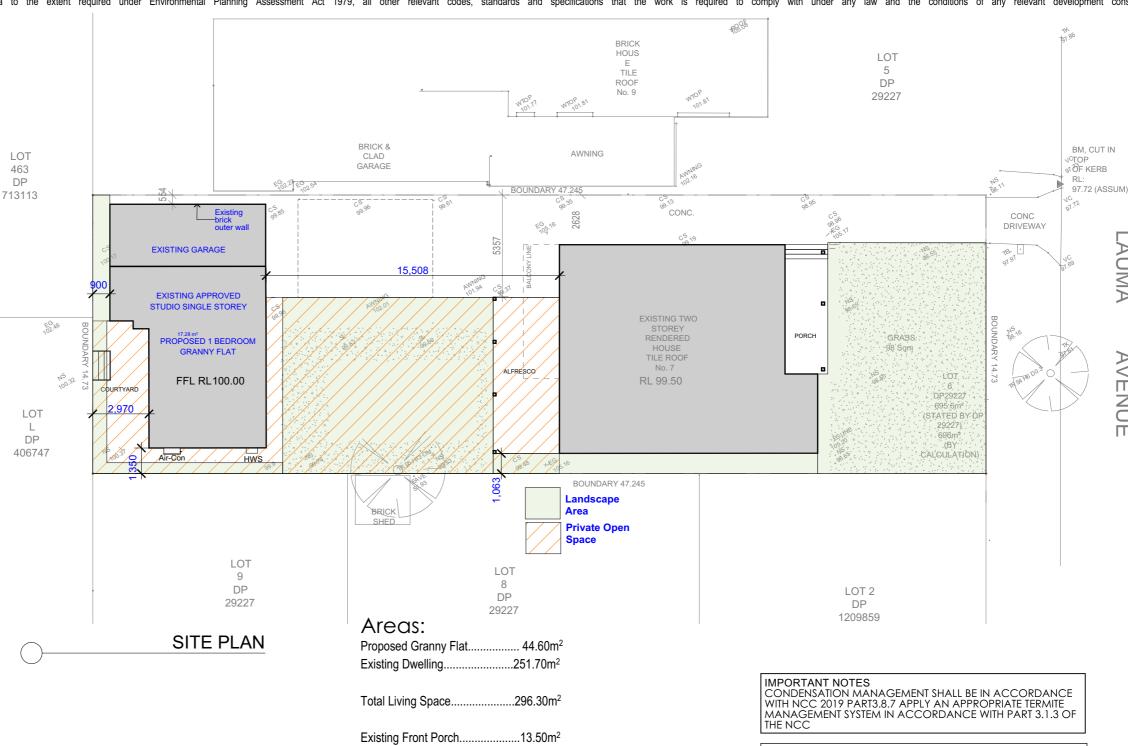

1. ALL WORK SHALL BE IN ACCORDANCE WITH THE BUILDING CODE OF AUSTRALIA A.A.S.3500.3.

AVENUE

- 2. ALL WORK SHALL BE IN ACCORDANCE LOCAL CONSENT AUTHORITY'S STANDARDS AND SPECIICATION, CODES AND THE
- SATISFACTION OF L.C.A. SUPERVISING OFFICER.
 3. MINIMAL GRADED SLOPE FOR ALL PIPEWORK SHALL BE 1.0%. DIRECT SURFACE FLOW TO ALL GRATED SURFACE INLET PITS.
- 5. ALL DESIGN LEVELS SHOWN ON PLAN SHALL BE VERIFIED ON SITE PRIOR TO THE COMMENCEMENT OF ANYWORK
- 6. ANY DISCREPANCIES FOR OMISSIONS SHALL BE REFERRED TO THE DESIGN ENGINEER FOR RESOLUTION.

UNAUTHORISED CONVERSION APPROVED STUDIO TO GRANNY FLAT

.28.90m²

..15.60m²

.68.00m²

.696.00m²

..194.00m²

..445.00m² 64%

..227.00m² 32.60%

..227.00m² 32.60%

..296.30m²42.57%

Sheet Title

Client 7 LAUMA AVENUE MASTER BUILDING GROUP PTY LTD


DP29227

GREENACRE Lot 6

SITE PLAN


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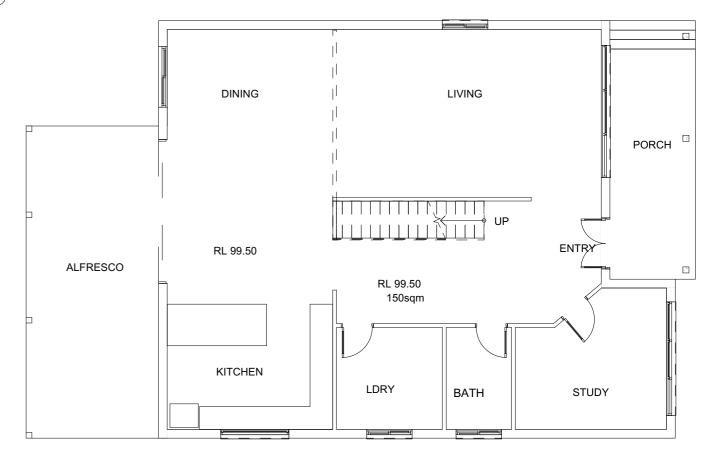


APPROVED STUDIO - PROPOED 1 BEDROOM GRANNY FLAT

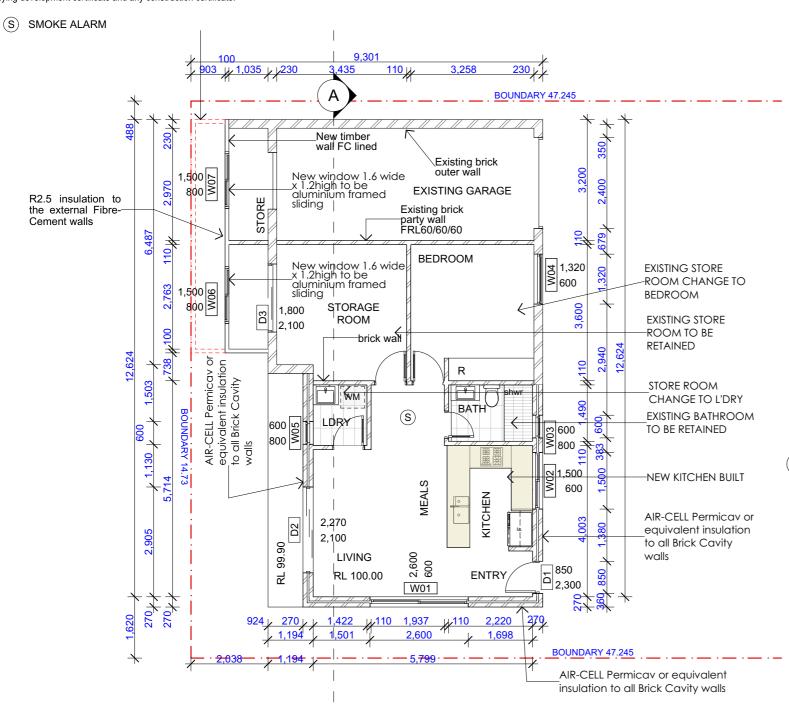ASSOCIATION OF AUSTRALIA



EXISTING DWELLING FIRST FLOOR PLAN

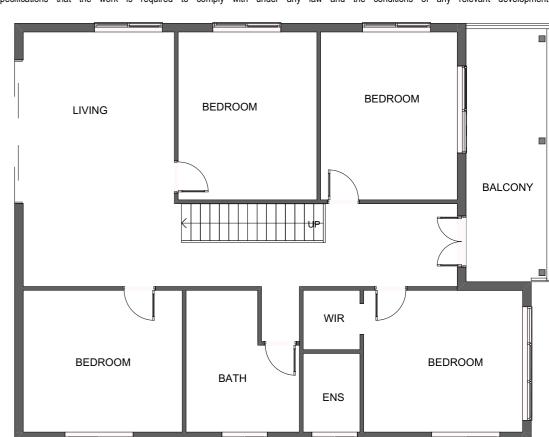

Sheet Title:

EXISTING DWELLING GROUND FLOOR PLAN

BUILDING DESIGNERS

BUILDING DESIGNERS

BUILDING DESIGNERS





UNAUTHORISED CONVERSION APPROVED STUDIO TO GRANNY FLAT

Client Address


MASTER BUILDING GROUP PTY LTD


GREENACRE Lot 6

DP29227

GROUND FLOOR PLAN


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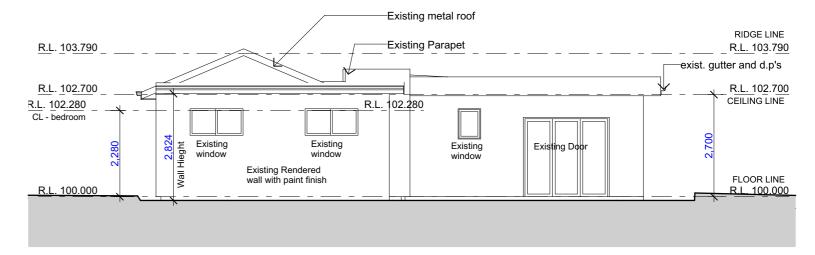


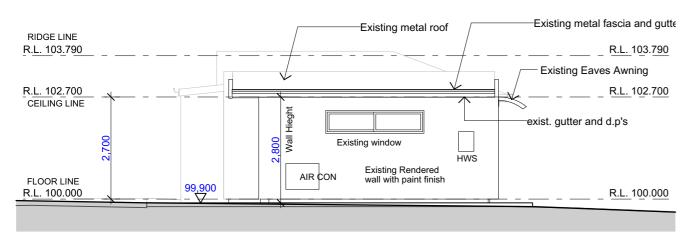

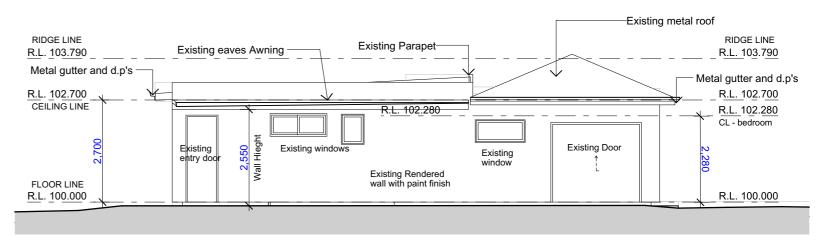NORTH ELEVATION


WEST ELEVATION



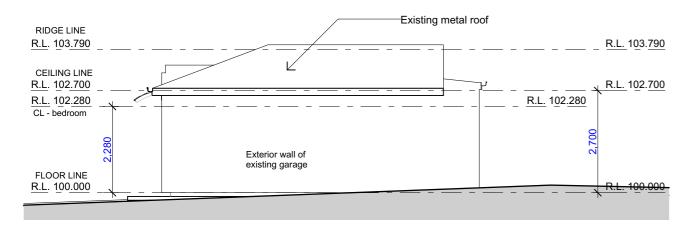

SOUTH ELEVATION

EAST ELEVATION

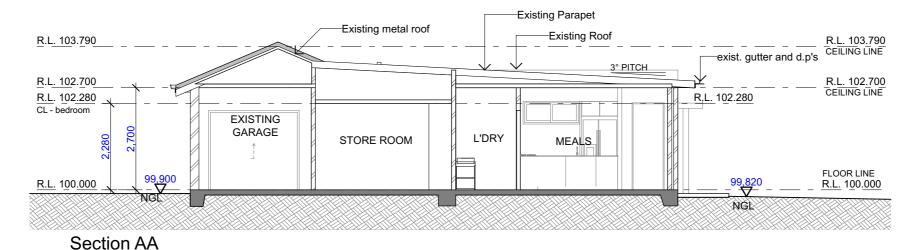

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	SED CONVERSION STUDIO TO GRANNY FLAT
Client	Address

Client Address

MASTER BUILDING GROUP PTY LTD

GREENACRE Lot 6
DP29227

Sheet Title:
ELEVATION AND SECTION

Quality of Work: All work carried out must comply with: Building Code of Australia to the extent required under Environmental Planning Assessment Act 1979, all other relevant codes, standards and specifications that the work is required to comply with under any law and the conditions of any relevant development consent or complying development certificate and any construction certificate.

	Window List						
ID	W01	W02	W03	W04	W05	W06	W07
W x H Size	2,600×600	1,500×600	600×800	1,320×600	600×800	1,500×800	1,500×800
3D Front View							

WINDOWS SCHEDULE

Door List						
ID	D1	D2	D2	D3		
W x H Size	850×2,300	2,270×2,100	2,400×2,100	1,800×2,100		
3D Front View			1			

DOORS SCHEDULE

SUMMARY OF BASIX COMMITMENTS								
Basix Certificate Number: 1780112S								
Certificate Prepared By:								
Name/Company Name: Green Choice Consulting								
	ABN: 63658893415							
	WATER COMMITMENTS							
Landscape	Landscape							
Area of Garden & Lawn (m²) 50.00								
Area of Indigenous	s or low water use species (m²)	0.00						
Fixtures								
	Showerheads	4 star (>4.5 but <	=6 L/min)					
	Toilet	5 star						
	Kitchen Taps	5 star						
	athroom Taps	5 star						
Alternative Water								
	from Roof Area (m²)	44.00						
	nwater Tank (L)	3000.00						
Tank Connected To		1						
Ga	arden & Lawns	Rainwater						
	Toilet	Town water Supply						
	Laundry	Town water Supply						
	All Hot water	Town water Supply						
Drir	king/Household	Town water Supply						
	ENERGY COMM							
Hot Water System	gas instantaneous	5 star						
Cooling	Living	1-phase airconditioning - non ducted	5 star					
	Bedroom	1-phase airconditioning - non ducted	5 star					
Heating	Living	1-phase airconditioning - non ducted	5 star					
	Bedroom	1-phase airconditioning - non ducted	5 star					
Vantilation	Bathroom Exhaust	individual fan, ducted to façade or roof	manual switch on/off					
Ventilation	Kitchen Exhaust	individual fan, ducted to façade or roof	manual switch on/off					
	Laundry Exhaust	individual fan, ducted to façade or roof	manual switch on/off					
Natural Lighting	Skylight or Window in Kitchen	yes						
Alternative Ener	Skylight or Window in Bathrooms/Toilets N/A	1						
Alternative Energy N/A OTHER COMMITMENTS								
	ooktop/Oven		ctric oven					
	oor Clothes line	gas cooktop & electric oven						
	oor Clothes line	yes						
inde	OU CIUUICO IIIIC	no						

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BASIX COMMINTMENTS

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WINDOWS AND DOORS SCHEDULE BASIX COMMITMENTS

Client Address

MASTER BUILDING GROUP PTY LTD

MASTER BUILDING GROUP PTY LTD

GREENACRE Lot 6
DP29227

Scale 1:1, 1:1.47

Issue ___ Drawing No.:

14/02/25 Sheet Number: 8

awing No.: Sheet Number 7lauma